### Attachment 6

AGENDA ITEM: #8 - M 1 R
DATE: 5-15-2015

# DO NOT REMOVE FROM FILE

				DO NOT HI	EIVIOVE PHO
9.	POPULATION/HOUSING - Will the project:	Potentially Significant	Impact can & will be mitigated	Insignificant Impact	Not Applicable
d)	Use substantial amount of fuel or energy?			$\boxtimes$	
e)	Other:				
Inve	ing In its efforts to provide for affordable stment Partnerships (HOME) Program an ram, which provides limited financing to party.	d the Commi	unity Developm	ent Block Gra	nt (CDBG)
Impa displ	act. The project will not result in a need ace existing housing.	for a significa	int amount of i	new housing, a	nd will not
	gation/Conclusion. No significant population measures are necessary.	lation and ho	using impacts	are anticipate	d, and no
10.	PUBLIC SERVICES/UTILITIES - Will the project have an effect upon, or result in the need for new or altered public services in any of the following areas:	Potentially Significant	Impact can & will be mitigated	Insignificant Impact	Not Applicable
a)	Fire protection?		$\boxtimes$		
b)	Police protection (e.g., Sheriff, CHP)?		$\boxtimes$		
c)	Schools?		$\boxtimes$		, 🔲
d)	Roads?			$\boxtimes$	
e)	Solid Wastes?			$\boxtimes$	
f)	Other public facilities?		$\boxtimes$		
g)	Other:				
appro (Cayu	ng. The project area is served by the interest as the primary emergency respond eximately 0.7 miles to the southeast. Thucos Station 11) located approximately 3.5 Los Osos, which is approximately 13 miles ayucos Elementary School District.	lers. The Cay e project an miles to the s	ucos Fire Depaga ea is also ser southeast The	artment station ved by CDF fi closest Sheriff	is located ire station

**Impact.** The project's direct and cumulative impacts are within the general assumptions of allowed use for the subject property that was used to estimate the fees in place.

Mitigation/Conclusion. Public facility (county) and school (State Government Code 65995 et sec) fee programs have been adopted to address the project's direct and cumulative impacts, and will


County of San Luis Obispo, Initial Study for SLO Land Corporation Minor Use Permit Page 12

reduce the impacts to less than significant levels.

11.	RECREATION - Will the project:	Potentially Significant	Impact can & will be mitigated	insignmeant impact	Applicable
a)	Increase the use or demand for parks or other recreation opportunities?			$\boxtimes$	
b)	Affect the access to trails, parks or other recreation opportunities?			$\boxtimes$	
c)	Other				
	ng. The County Trails Plan shows that a poroject is not proposed in a location that will				
impa resou	ct. The proposed project will not create irces.	a significant	need for addit	ional park or re	ecreational
_	ation/Conclusion. No significant recreases are necessary.	eation impac	ts are anticip	ated, and no	mitigation
12.	TRANSPORTATION/ CIRCULATION - Will the project:	Potentially Significant	impact can & will be mitigated	Ins <b>ignific</b> ant Impact	Not Applicable
a)	increase vehicle trips to local or areawide circulation system?			$\boxtimes$	
<i>b</i> )	Reduce existing "Levels of Service" on public roadway(s)?				
c)	Create unsafe conditions on public roadways (e.g., limited access, design features, sight distance, slow vehicles)?				
d)	Provide for adequate emergency access?				
<b>e</b> )	Result in inadequate parking capacity?			$\boxtimes$	
f)	Result in inadequate internal traffic circulation?			$\boxtimes$	
<b>g)</b>	Conflict with adopted policies, plans, or programs supporting alternative transportation (e.g., pedestrian access, bus turnouts, bicycle racks, etc.)?				

12.	TRANSPORTATION/ CIRCULATION - Will the project:	Potentially Significant	Impact can & will be mitigated	Insignificant Impact	Not Applicable
h)	Result in a change in air traffic patterns that may result in substantial safety risks?				
i)	Other:				
Drive all lot three Aven of a	ng. Future development will access onto ) and E Street are operating at acceptable is, therefore an easement will be required parcels. A Curb, Gutter and Sidewalk will ue. The project also has access from the account settlement, the alley can be used for identified.	e levels. Birch over the adja vaiver has be alley located a	n Avenue will I cent parcel for en approved I along the south	be the access of the benefit of by Public Work em boundary.	Iriveway to the subject s for Birch As a result
impa will n	ct. The proposed project is 3 single fami	ly residences	. This small a ice or traffic sa	mount of addit	ch Avenue
will t fire/e Mittig	ot result in a significant change to the exist of a dead end street because of the loc mergency access.  Station/Conclusion. The site plan had attend. The project has been conditioned.	ation of Little	wed and app	eek, which cou proved by Cay	rucos Fire
wili t fire/e Mitig Depa	be a dead end street because of the loc mergency access.	ation of Little	wed and app	eek, which cou proved by Cay	rucos Fire
will the fire/emittig  Mittig  Deparement	be a dead end street because of the loc mergency access. ation/Conclusion. The site plan had artment. The project has been conditioned	ation of Little	wed and app	eek, which cou proved by Cay	rucos Fire tallation of
will the fire/emiling Deparent parent	the a dead end street because of the loc mergency access.  Sation/Conclusion. The site plan had artment. The project has been conditioned arking signs.  WASTEWATER - Will the	been revie for no parkin	wed and app g on Birch Ave impact can & will be	eek, which cou proved by Cay enue and for ins insignificant	rucos Fire tallation of
with the fire/e. Mittig Deparation particular particula	pe a dead end street because of the loc mergency access.  Hation/Conclusion. The site plan had artment. The project has been conditioned arking signs.  WASTEWATER - Will the project:  Violate waste discharge requirements or Central Coast Basin Plan criteria	been revie for no parkin	wed and app g on Birch Ave impact can & will be	eek, which cou proved by Cay enue and for ins insignificant impact	rucos Fire tallation of
will the fire/ending of the fire of the fi	the a dead end street because of the local mergency access.  Settlon/Conclusion. The site plan had artment. The project has been conditioned arking signs.  WASTEWATER - Will the project:  Violate waste discharge requirements or Central Coast Basin Plan criteria for wastewater systems?  Change the quality of surface or ground water (e.g., nitrogen-loading,	been revie for no parkin	wed and app g on Birch Ave impact can & will be	eek, which country or	rucos Fire tallation of
with the fire/e. Mittig Deparation per 13.	the a dead end street because of the local mergency access.  Settlon/Conclusion. The site plan had artment. The project has been conditioned arking signs.  WASTEWATER - Will the project:  Violate waste discharge requirements or Central Coast Basin Plan criteria for wastewater systems?  Change the quality of surface or ground water (e.g., nitrogen-loading, daylighting)?  Adversely affect community	been revie for no parkin	wed and app g on Birch Ave impact can & will be	eek, which countries to convert by Cayenue and for instant impact.	rucos Fire tallation of

County of San Luis Obispo, Initial Study for SLO Land Corporation Minor Use Permit Page 14

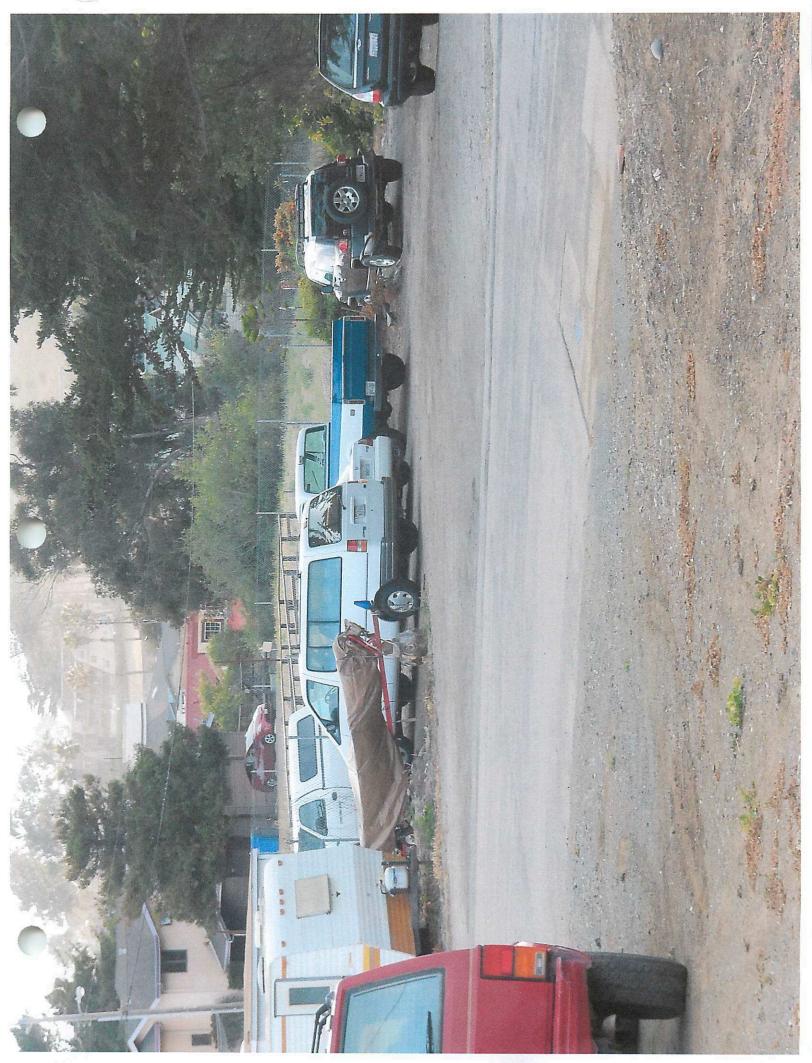

Stage 1 includes an initial site inspection to delineate the content and extent of surface and subsurface deposits, ultimately mapping the archeological site boundaries vis-à-vis the proposed three Work Areas. Focused investigation will be conducted in Work Area 1 and 2, and additional sampling will be done in Work Area 3 to help focus data recovery effort in that area. Based on the Stage 1 findings, final recommendation on the excavation volumes needed to mitigate site impacts and achieve the objectives of the research design, based on actual volume of site disturbance will be submitted to the County Planning and Building review and approval prior proceeding to Stage 2.

Stage 2 concentrates on data recovery excavation in the Work Area 2 and 3, and recovers statistically valid and appropriate sized samples for data analysis. The bulk of site disturbance is anticipated in the Work Area 2 and 3 during construction of the shared driveway, building pads, and residences. The updated Plan recommended between 3 to 10 cubic meters of excavation within the affected cultural deposits for data recovery. Final volume will be dictated by the results of the Stage 1 investigation, and the mapping of archeological site boundaries and contents in relation to the three Work Areas.

Construction monitoring by an archeological monitor and Native American tribal representative will be required during any ground disturbing activities. Data recovery fieldwork for all three Work Areas is anticipated to be completed concurrently during the initial construction of Work Area 1. Prior to any construction activities, this project is conditioned for a detailed Phase III Mitigation and Monitoring plan, subject to the guidelines in the updated Phase III Archeological Work Plan (Applied Earthworks, 2015) and approval by the County Department of Planning and Building.

### COMMUNITY ADVISORY GROUP COMMENTS:

Cayucos Community Advisory Council – Recommended approval on February 4, 2015.

### **AGENCY REVIEW:**

**Public Works** – Project granted a Curb, Gutter and Sidewalk waiver. The project is within a drainage review area and a drainage plan is required. The project meets the applicability criteria for Stormwater Management and shall comply with applicable requirements. (Frank Honeycutt, Oct 22, 2014)

Cayucos Sanitary District – Project is subject to will-serve letter conditions issued in 2005 and any applicable requirements today. Extension fees required (CSD, April 2015)

Morro Rock Mutual Water Company - Will serve letter issued ( June 26, 2014)

Cayucos Fire Department – Project is subject and not limited to, comments/ items listed on letter dated August 29, 2002 and fax dated 9/8/06 (Bill Radke, Fire Chief). No comments (Darrin Carlson, Sept 25, 2014)

California Coastal Commission - Quit Claim Deed required.(Nov 17, 2014)

# P.O. BOX 707 201 CAYUCOS DRIVE CAYUCOS, CA 93430

PH: 805-995-3372 FX: 805-995-0953

Aug. 29, 2002

To: Coastal Team

S.L.O. Co. Department of Planning and Building

Subject: Project #D020030P (Anderson/Thomas)

I am enclosing a copy of a preliminary site evaluation I did for this location at the request of one of the bidders. (It was available to other interested parties.) In it I tried to make a case for developing the Birch St. access instead of utilizing the alley, as proposed in this application. The reasons I gave are as follows:

 Uniform Fire Code and SLO Co Developers Guide require a traffic turn-around at the end of a dead-end street over 150 feet in length. That will be difficult on

Birch St. but nearly impossible on the alley.

- 2. Road width (travel lanes, exclusive of parking) must be 20 feet. That's the entire legal width of the alley. Existing structures (power poles, fences, etc.) already encroach on this minimum width. I don't think this condition can be met without some additional land being dedicated for road improvements. Also, from local experience I can't recommend residential construction without on-street parking.
- We would expect the access road to be maintained either by the County or by a
  binding agreement of the property owners, administered by the county. I question
  whether the existing alley neighbors will be interested in joining into such an
  agreement.

4. I mentioned a problem with assigning street address in an alley but I suppose the alley would be given a name ("Poquito Place"?) and numbers assigned.

As you may gather, I think the access should be Birch St. improvements, not the alley. If the alley is accepted, it will need to be 20 feet wide, posted "No Parking", and be designed and maintained to support the imposed loads of 20 tons at 25 mph, and shall be provided with a surface so as to provide all-weather driving capabilities and maintain 90% compaction. Further, a turn-around must be provided near the end which must also meet the above requirements.

Bill Radke, Fire Chief

Higher Talked w/ Bill Radke - turn around an shown on plane Ox; loadifion for sproval by fire prior to issuauce

201 CAYUCOS DRIVE CAYUCOS, CA 83439

Phone 805-995-3372 Fax 805-995-0953

**CAYUCOS FIRE PROTECTION** 




To:	MARSHA LEE (SLO CO, PLANNING)	From	BILL RADKE
Face	781-1242	Pagest	2
Phones	788-2008	Date:	9/8/2006
Ret	BIRCH ST IMPROVEMENTS	CC:	
	MAR INVESTMENTS		
	For Review		

## Marsha,

Attached is a copy of a fax sent to John Mac Donald on 7-12-04 sharing our concerns for the development of the Birch St. extension for the proposed construction of 3 single family dwellings... Those concerns are still valid and consistent with our current requirement. John Mac Donald provided us a site plan dated 18-23-06 that appears to address the road width/turn-around issues. We would like to see the "Fire Lane" posting and the recorded CC&R included as conditions of development permit.

Let me know if you need any additional information.


Bill Radke, Fire Chief

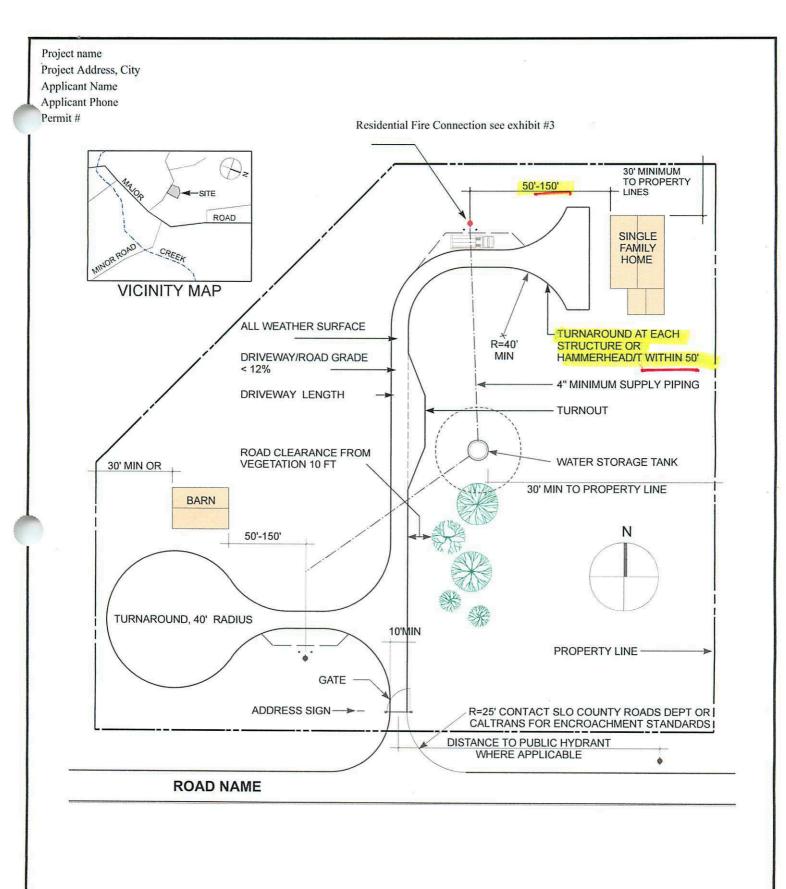

# SAMPLE SITE PLAN FIRE SAFE EXHIBIT CAL FIRE/SLO COUNTY FIRE DEPARTMENT 1" = 50" FIRE PREVENTION SCALE 635 N. Santa Rosa Avenue San Luis Obispo, California 93405 Telephone (805) 543-4244 Fax (805) 543-4248 August 2011 EXHIBIT NO.

Revisions Description Approved Description Approved Date

> COMMERCIAL USE: HAMMERHEADS SHALL NOT **BE USED FOR COMMERCIAL PROJECTS**

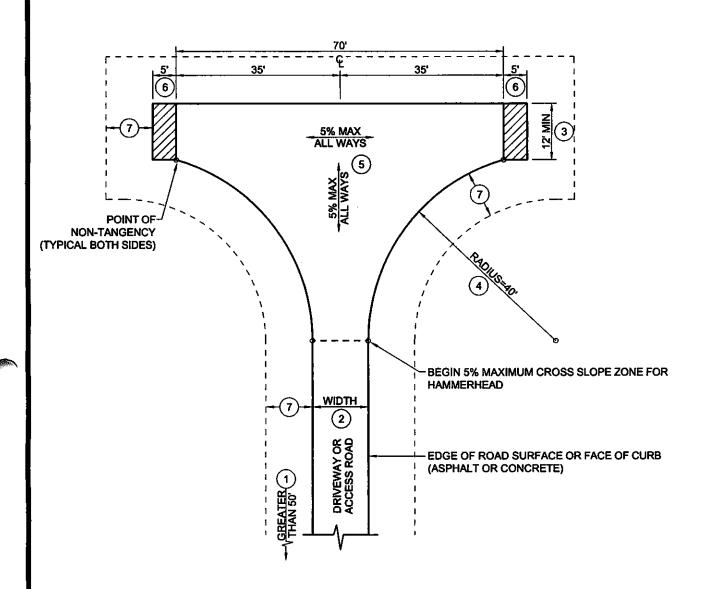

#### NOTES:

- 1. TURNAROUNDS SHALL BE REQUIRED WHEN DRIVEWAYS OR ACCESS ROADS EXCEED 50-FEET IN LENGTH OR AS REQUIRED BY THE DEPARTMENT.
- 2. WIDTH OF THE DRIVEWAY OR ACCESS ROAD SHALL BE PER DEPARTMENT REQUIREMENTS.
- 3. WIDTH SHALL BE WIDTH OF DRIVEWAY OR ACCESS ROAD BUT 12-FEET MINIMUM IS REQUIRED.
- 4. ALL RADII SHALL BE MEASURED TO THE EDGE OF DRIVING SURFACE OR FACE OF ASPHALT DIKE OR CONCRETE CURB.
- 5. MAXIMUM CROSS SLOPE THROUGHOUT THE TURNOUT SHALL NOT EXCEED 5% IN ANY DIRECTION,
- 6. OPTIONAL: VEHICLE OVERHANG LIMITS, DRIVING SURFACE IN THIS AREA IS NOT REQUIRED HOWEVER SURFACE SHALL BE CLEAR OF OBSTRUCTIONS AND HAVE A LEVEL SURFACE.
- 7. VEGETATION CLEARANCE REQUIREMENTS PER FSS EXHIBIT No. 6.0 SHALL APPLY.



SAN LUIS OBISPO COUNTY FIRE DEPARTMENT Scale: PRIVATE DRIVEWAY & ACCESS ROAD TURNAROUND-HAMMERHEAD

1"=20"

Adopted: **AUG 2014** 


2 OF 3

Fire Safe Drawing No:

Sheet No:

Revisions								
Description	Approved	Date	Description	Approved	Date			

COMMERCIAL USE: HAMMERHEADS SHALL NOT BE USED FOR COMMERCIAL PROJECTS

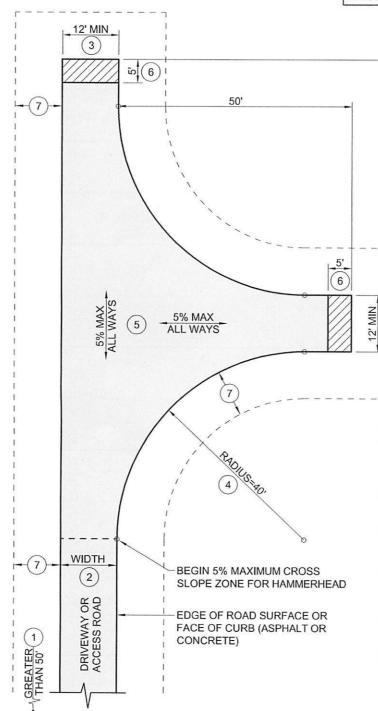

### NOTES:

3

50'

- TURNAROUNDS SHALL BE REQUIRED WHEN DRIVEWAYS OR ACCESS ROADS EXCEED 50-FEET IN LENGTH OR AS REQUIRED BY THE DEPARTMENT.
- WIDTH OF THE DRIVEWAY OR ACCESS ROAD SHALL BE PER DEPARTMENT REQUIREMENTS.
- WIDTH SHALL BE WIDTH OF DRIVEWAY OR ACCESS ROAD BUT SHALL NOT BE LESS THAN 12-FEET.
- 4. ALL RADII SHALL BE MEASURED TO THE EDGE OF DRIVING SURFACE OR FACE OF ASPHALT DIKE OR CONCRETE CURB.
- MAXIMUM CROSS SLOPE THROUGHOUT THE TURNOUT SHALL NOT EXCEED 5% IN ANY DIRECTION.
- 6. OPTIONAL: VEHICLE OVERHANG LIMITS, DRIVING SURFACE IN THIS AREA IS NOT REQUIRED HOWEVER SURFACE SHALL BE CLEAR OF OBSTRUCTIONS AND HAVE A LEVEL SURFACE.
- VEGETATION CLEARANCE REQUIREMENTS PER FSS EXHIBIT No. 4.0 SHALL APPLY.



SAN LUIS OBISPO COUNTY FIRE DEPARTMENT PRIVATE DRIVEWAY & ACCESS ROAD

TURNAROUND-MODIFIED HAMMERHEAD

Scale: 1"=20' Adopted: AUG 2014

Fire Safe Drawing No:

FS-4.2

Sheet No:

3 OF 3

